VENT THROUGH ROOF

ELEVATION ABOVE FINISH FLOOR

CURTAIN WALL / LOUVER TYPE

FIRE EXTINGUISHER IN WALL MOUNTED CABINET (SURFACE MOUNTED)

PARTITION TYPE

WINDOW / STOREFRONT /

FEC-B

FIRE EXTINGUISHER IN WALL MOUNTED CABINET (SEMI-RECESSED)

TOILET ACCESSORY SYMBOL

FIRE EXTINGUISHER ON WALL BRACKET FD - FLOOR DRAIN

FIRE RATED WALL SYMBOLS

NOTE: SEE PARTITION TYPES FOR UL DESIGNATION NO.'S

ONE-HOUR FIRE RATED WALL ASSEMBLY TWO-HOUR FIRE RATED WALL ASSEMBLY THREE-HOUR FIRE RATED WALL ASSEMBLY FOUR-HOUR FIRE RATED WALL ASSEMBLY

BRICK VENEER / CMU CONTROL JOINT

GYPSUM BOARD CONTROL JOINT

REVISION SYMBOL

SMOKE PARTITION



CLOUD AROUND REVISION

BELKA ENGINEERING ASSOCIATES INC 7 CLUSTERS COURT COLUMBIA, SC 29210


T: 803-731-0650 F: 803-731-2880 **INDEX OF DRAWINGS**

COVER SHEET, INDEX OF DRAWINGS DEMOLITION FLOOR PLAIN, CEILING PLAN, AND NOTES RENOVATION FLOOR PLAN, CEILING PLAN. AND NOTES

FLOOR PLAN, NOTES, SCHEDULES, AND LEGEND

GROUND LEVEL FLOOR PLAN - A GROUND LEVEL FLOOR PLAN - B FLOOR PLANS, NOTES, SCHEDULE, AND LEGEND

KEY PLANS

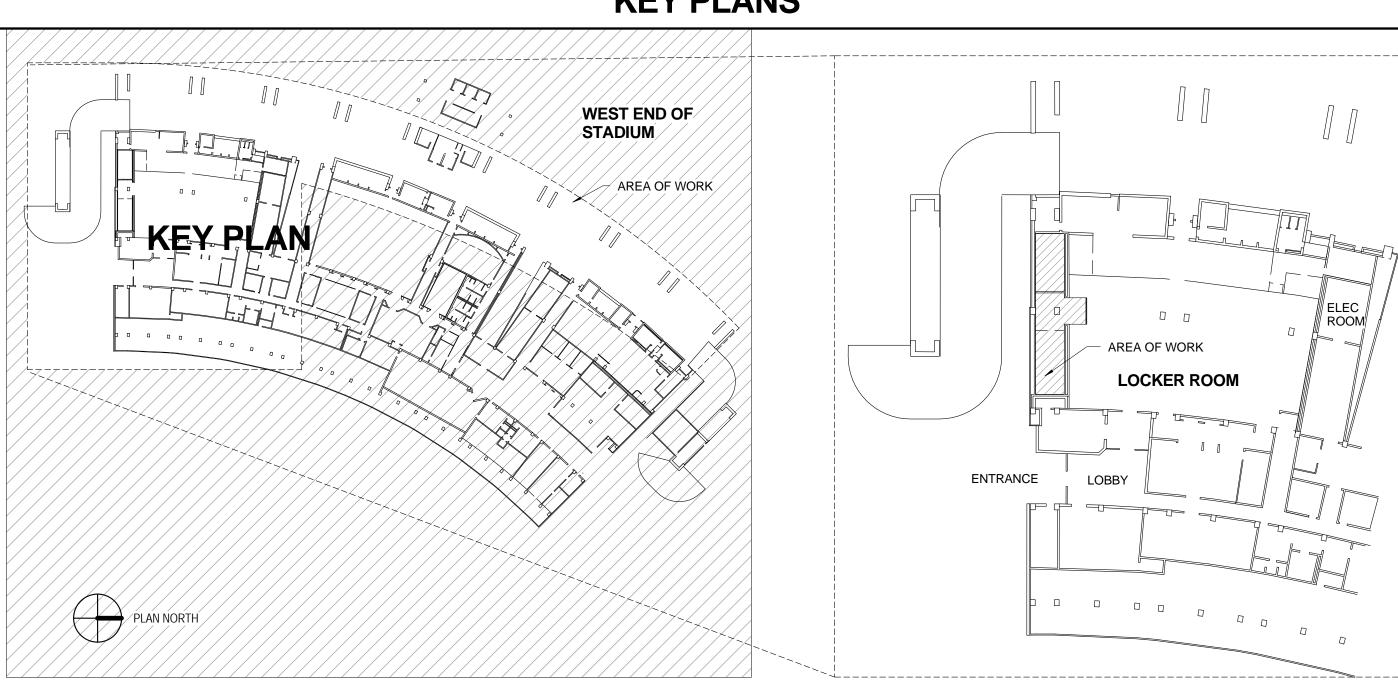

PLUMBING REPA MODIFICATIONS

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BID DOCUMENTS

ISSUE DATE PROJECT NO. 15.162.00 STATE PROJECT NO. CP00419682

REVISION

COVER SHEET, INDEX OF DRAWINGS

SHEET NO

DATE

16. Contractor may utilize adjacent restroom facilities. After construction is completed, restrooms shall be cleaned.

18. Schedule loud activities with owner prior to beginning (i.e. removal of ceramic tile and concrete slab).

to protect existing flooring from dirt, debris, dents, depressions, marks, etc.

20. Protect all existing lockers and doors within existing locker room from damage and dust.

21. Protect all existing toilet fixtures, urinals, shower heads, soap dispensers, etc. to remain.

dust and debris within reasonable time frame.

17. During dusty activities provide plastic protection to contain dust and debris to limited area (shower and toile room area). Clean


19. Protect existing carpet in locker room and existing rubber flooring in existing Lobby area. Lay down plastic or paper or plywood


- EXISTING TILE FLOOR TO REMAIN; PROTECT EXISTING FLOORING DURING DEMOLITION AND CONSTRUCTION IN AFFECTED AREA.
- ALL EXISTING SHOWER PARTITIONS TO BE REMOVED PRIOR TO DEMOLITION AND NEW CONSTRUCTION. CONTRACTOR SHALL NUMBER PARTITIONS AS TO LOCATION AND PLACE ALL FASTENERS IN NUMBERED BAGS. STORE PARTITIONS IN LOCATION PROVIDED BY OWNER. CONTRACTOR IS RESPONSIBLE TO REPLACE ALL DAMAGED OR UNUSABLE FASTENERS. COORDINATE REMOVAL WITH OWNER AND ARCHITECT PRIOR TO MOVING.
- REMOVE EXISTING WALL TILE AND ASSOCIATED GROUT IN THEIR ENTIRETY AT ALL WALLS AROUND ROOM. TILE BASE TO REMAIN; PROTECT EXISTING TILE BASE DURING DEMOLITION AND CONSTRUCTION IN AFFECTED AREA. REMOVE MASONRY WALL FROM A HEIGHT OF 2'-8" AFF AND ABOVE AS REQUIRED TO ACCESS PIPING - CONTRACTOR IS RESPONSIBLE FOR MAINTAINING STABILITY OF WALL DURING CONSTRUCTION; REFER TO PLUMBING FOR DETAILS REGARDING NEW PIPING. PATCH MASONRY WALL WITH CMU TO MATCH EXISTING. SMOOTH FLUSH AND PREPARE SURFACE TO RECEIVE NEW WALL TILE.
- REMOVE EXISTING WALL TILE AND ASSOCIATED GROUT IN THEIR ENTIRETY AT ALL WALLS AROUND ROOM. TILE BASE TO REMAIN; PROTECT EXISTING TILE BASE DURING DEMOLITION AND CONSTRUCTION IN AFFECTED AREA. PREPARE SURFACE TO RECEIVE NEW WALL TILE.
- REMOVE CMU AS REQUIRED TO INSTALL PIPING, VALVE AND 16" x 16" ACCESS PANEL SEE PLUMBING FOR DETAILS.
- REMOVE CMU AS REQUIRED TO INSTALL PIPING, VALVE AND 24" x 24" ACCESS PANEL SEE
- EXISTING CEILING AND ASSOCIATED STRUCTURE TO BE REMOVED IN THEIR ENTIRETY REMOVE AND CLEAN ALL LOOSE DEBRIS, INSULATION, ETC. ABOVE CEILING AREA. ALLOW ARCHITECT AND OWNER TO REVIEW PRIOR TO INSTALLING NEW CEILING.
- (D8) EXISTING LIGHT FIXTURES TO BE REMOVED; SAVE AND PROTECT FOR REINSTALLATION IN SAME LOCATION. CLEAN AND RELAMP PRIOR TO REINSTALLING.
- (D9) EXISTING GRILLE TO BE REMOVED IN ITS ENTIRETY SEE MECHANICAL.
- (D10) EXISTING SHOWER HEADS TO BE REMOVED SEE PLUMBING.


GENERAL DEMOLITION NOTES:


- A. EXISTING CONDITIONS ILLUSTRATED AS OF FEBRUARY 16, 2015.
- B. CONTRACTOR SHALL VERIFY ALL DIMENSIONS WITH EXISTING CONDITIONS FOR SIZES, QUANTITIES,
- C. ALL EXISTING ITEMS TO REMAIN SHALL BE PROTECTED DURING DEMOLITION AND NEW CONSTRUCTION. PROTECT EXISTING CARPET AND LOBBY FLOOR FINISHES DURING DEMOLITION AND
- D. IN AREAS OF WORK, AT EXISTING WALLS TO REMAIN WHERE OUTLETS, THERMOSTATS, LIGHT FIXTURES, PIPING, ATTACHMENTS AND DEVICES ARE REMOVED, PATCH AND REPAIR WALL TO MATCH EXISTING WALL TEXTURE. PREPARE WALL TO RECEIVE NEW FINISHES TO MATCH ADJACENT. FINISH WALL TO MATCH ADJACENT.
- E. PROTECT ALL EXISTING WALL ITEMS TO REMAIN (HOOKS, ELECTRIC HAIR DRYERS, ETC).
- F. OWNER TO REMOVE AND REINSTALL EXISTING SOAP DISPENSERS.

DEMOLITION LEGEND:

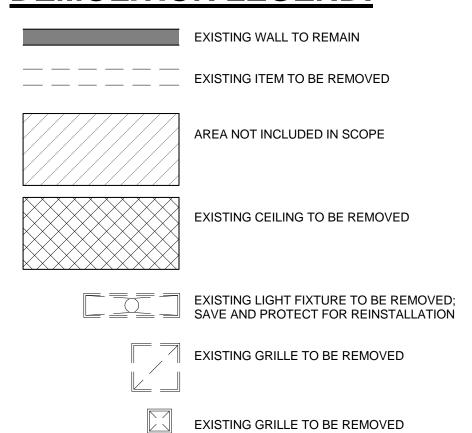

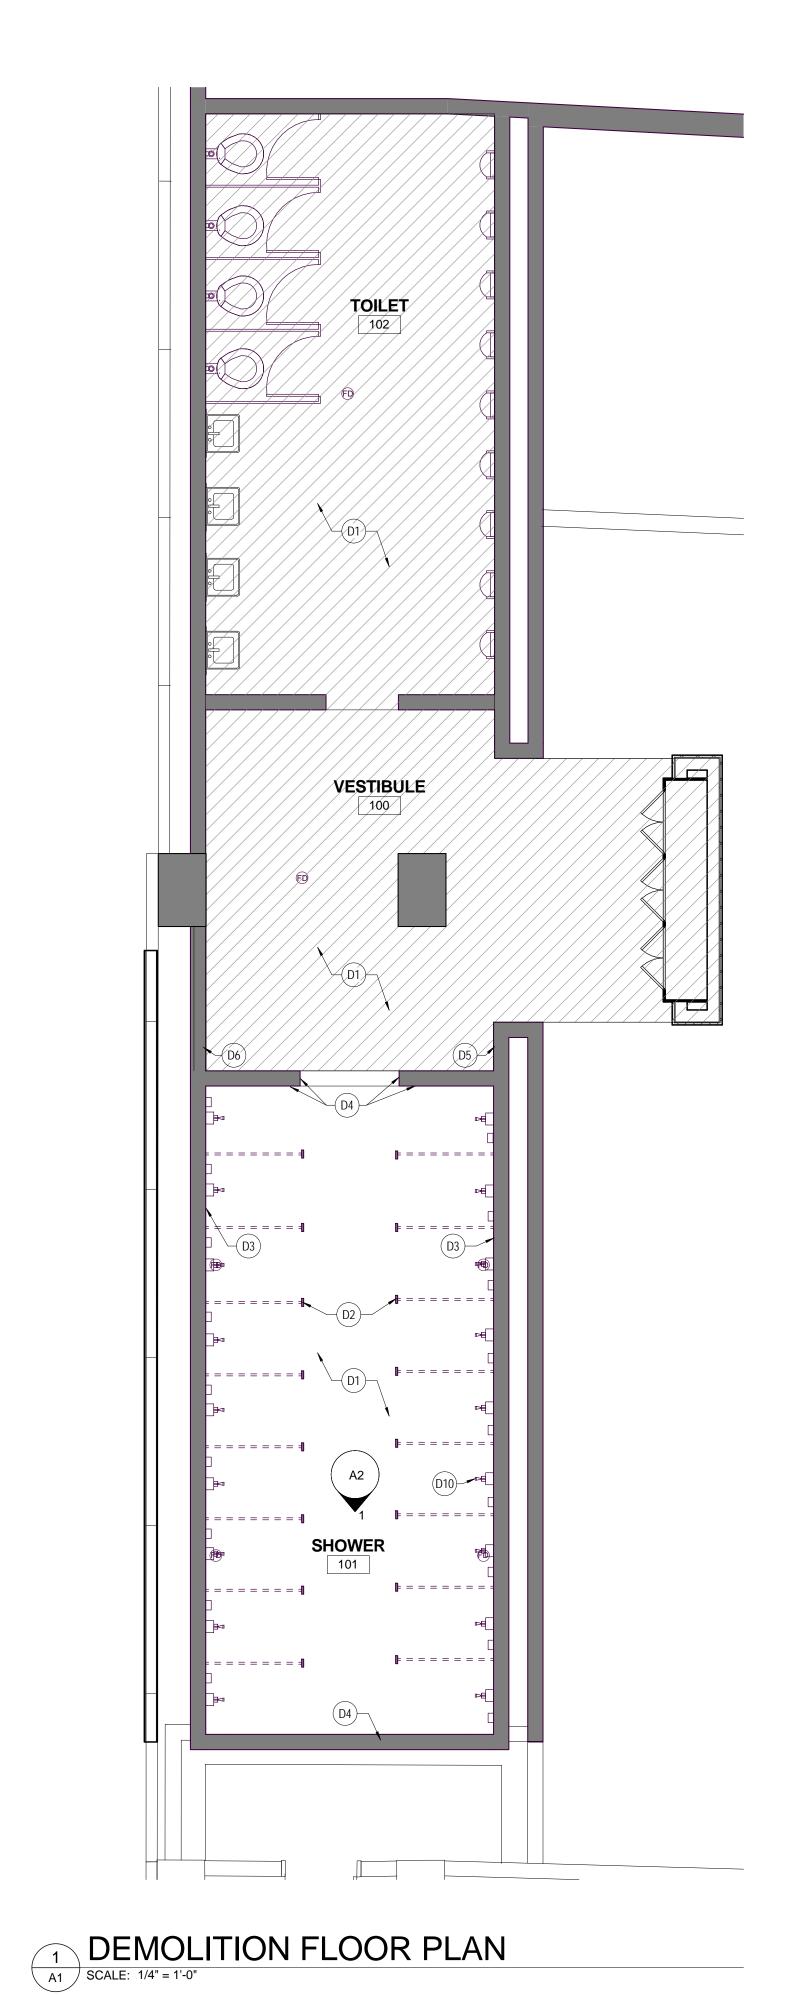

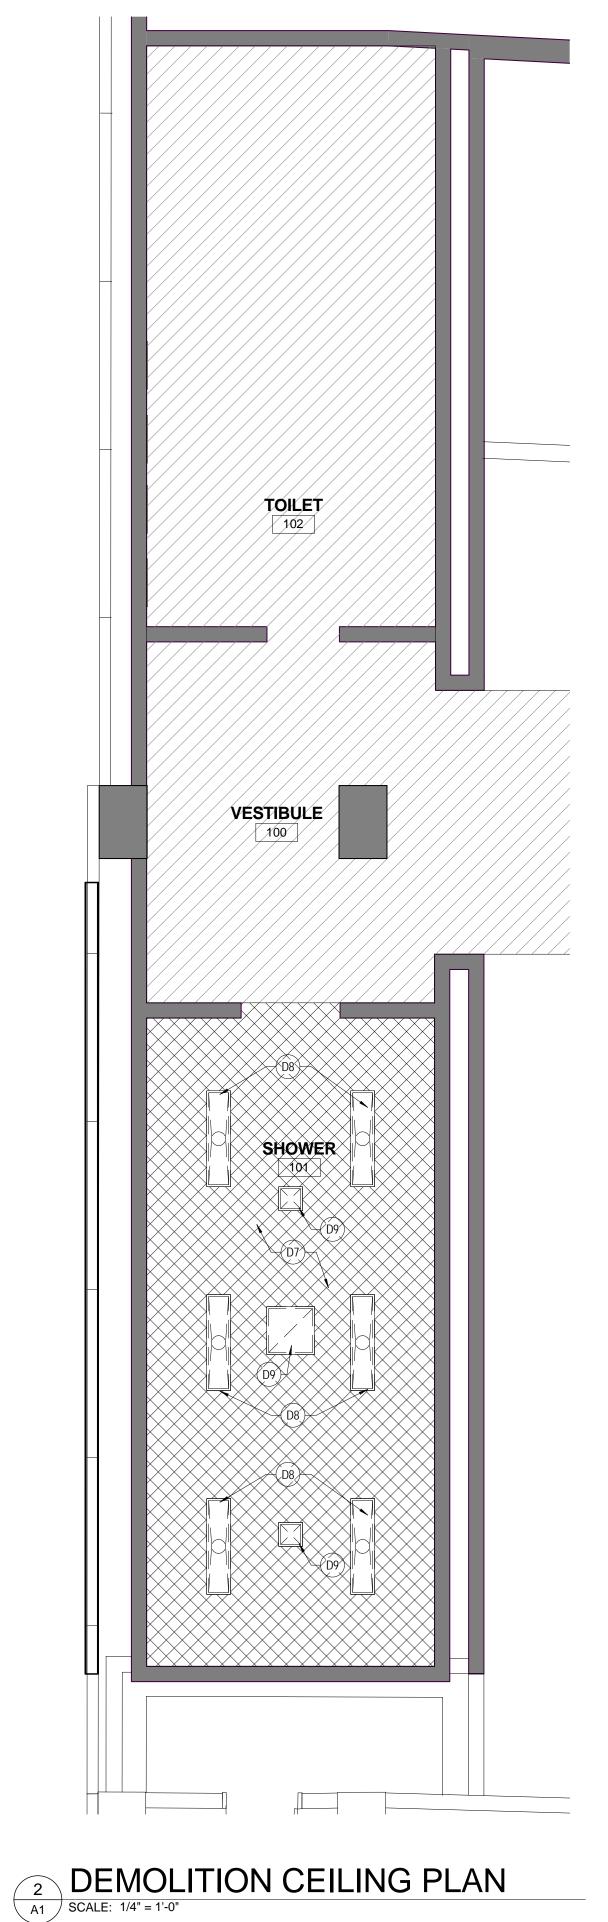

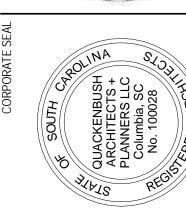

PLUMBING REPAIRS AND MODIFICATIONS, WBS

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ISSUE DATE PROJECT NO. 15.162.00 STATE PROJECT NO. CP00419682

REVISION

DATE

DEMOLITION FLOORPLAN, CEILING PLAN AND NOTES

SHEET NO

CONCRETE SLAB PATCHING: AT AREAS SHOWN ON PLUMBING DRAWINGS FOR NEW VALVES AT CONCOURSE AREA, PATCH CONCRETE WITH 4,000 PSI CONCRETE SMOOTHED FLUSH WITH ADJACENT CONCRETE. SEE P1 AND P2 FOR ADDITIONAL INFORMATION.

REPAINT CEILING TO

MATCH EXISTING

FIRE ALARM A/V SEE ELECTRICAL

INSTALL "V" PLASTIC

CONTROL JOINT AT

CONTROL JOINT AT

CEILING /



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ISSUE DATE PROJECT NO. 15.162.00 STATE PROJECT NO. CP00419682

REVISION

FLOOR PLAN, CEILING PLAN, AND NOTES

SHEET NO

RENOVATION NOTES TO SHEET

REINSTALL ALL SHOWER PARTITIONS IN SAME LOCATIONS AS REMOVED. INSTALL NEW WALL TILE TO FULL HEIGHT OF WALLS STARTING ABOVE EXISTING TILE BASE; REFER TO TYPICAL TILE PATTERN ELEVATION FOR DETAILS. PROVIDE BULLNOSE AT ENTRANCE AREA CORNERS.

INSTALL NEW 16" x 16" ACCESS PANEL (STAINLESS STEEL) FOR PLUMBING VALVE - SEE PLUMBING. EACH ACCESS PANEL TO RECEIVE MORTISE CYLINDER LOCK (1E74-C4 BEST LOCK CYLINDER - OR APPROVED EQUAL PRODUCT).

INSTALL NEW 24" x 24" ACCESS PANEL (STAINLESS STEEL) FOR PLUMBING VALVE - SEE PLUMBING. EACH ACCESS PANEL TO RECEIVE MORTISE CYLINDER LÓCK (1E74-C4 BEST LOCK CYLINDER - OR

EXISTING TILE FLOOR TO REMAIN; PROTECT EXISTING FLOORING DURING DEMOLITION AND CONSTRUCTION IN AFFECTED AREA.

PAINT WALLS FROM CORNER TO CORNER; PAINT TO MATCH EXISTING.

NEW SHOWER HEADS - SEE PLUMBING.

GENERAL RENOVATION NOTES:

A. CONTRACTOR SHALL COORDINATE ALL WORK WITHIN EXISTING AREA WITH OWNER

B. CONTRACTOR TO CLEAN ENTIRE WORK AREA PRIOR TO BEGINNING WORK. PREPARE ALL SURFACES AS REQ'D TO RECEIVE NEW FINISHES.

C. SEAL PERIMETER OF CEILINGS W/ SILICONE, ANTIMICROBIAL

D. OWNER TO REMOVE AND REINSTALL EXISTING SOAP DISPENSERS.

E. PATCH CMU INFILL TO MATCH EXISTING AT ALL AREAS REMOVED FOR PLUMBING WORK

INTERIOR FINISH MATERIALS

(SEE SPECS FOR SYSTEM)

AREA NOT INCLUDED IN SCOPE

NEW GYPSUM BOARD CEILING - MATCH

PREVIOUSLY EXISTING CEILING HEIGHT

SEAL PERIMETER WITH SILICONE SEALANT

CERAMIC TILE (CT) GROUT (GR)

RENOVATION LEGEND

MANUFACTURER: ROCA LIFE 10" x 28"

GR-1 MANUFACTURER: LATICRETE 24 - NATURAL GREY COLOR:

EPOXY CEILING PAINT TO MATCH EXISTING (WHITE)

	ROOM FINISH SCHEDULE									
	ROOM FLOOR WALLS					CEILING				
ROOM NO	NAME	FINISH	BASE	NORTH	SOUTH	WEST	EAST	FINISH	REMARKS	
101	SHOWER	EXISTING	EXISTING	CT-1, GR-1	CT-1, GR-1	CT-1, GR-1	CT-1, GR-1	P-1	1	

REMARKS

INSTALL NEW WALL TILE TO FULL HEIGHT OF WALLS STARTING ABOVE EXISTING TILE BASE: REFER TO TYPICAL TILE PATTERN ELEVATION FOR DETAILS.

GENERAL FINISH NOTES

A. PREPARE ALL EXISTING WALLS, CEILING, AND FLOORS TO RECEIVE NEW FINISHES AS SCHEDULED.

EXISTING WALLS AND EXISTING CEILINGS: AFTER REMOVING PEELING PAINT FROM WALLS, PRIME WITH XIM PEEL BOND PRIMER #1146 AND PAINT WITH 2 COATS OF SHERWIN WILLIAMS PRE-CATALYZED WATERBASED D. LAP ALL #4 BARS 2'-4" EPOXY EG-SHEL (COLOR TO MATCH EXISTING)


NEW CEILING - GYPSUM BOARD ASSEMBLY:

1 LAYER OF 1/2" THICK USG DUROCK EXTERIOR CEMENT BOARD OR APPROVED EQUAL (MAX FASTENER SPACING 6" OC W/ MANUFACTURER APPROVED FASTENERS) W/ 1 LAYER OF 1/2" THICK USG FIBEROCK INTERIOR PANEL AQUA-TOUGH OR APPROVED EQUAL WITH MANUFACTURER APPROVED JOINT FINISHING

PREP RITE 200 LATEX PRIMER WITH 2 COATS OF SHERWIN WILLIAMS PRE-CATALYZED WATERBASED EPOXY


PROVIDE 1 GALLON MINIMUM OF EACH PAINT TYPE OF EXTRA PAINT TO OWNER AFTER PROJECT IS FINISHED

PAINT ALL EXPOSED CONDUIT (NEW/EXISTING) TO MATCH ADJACENT WALL.

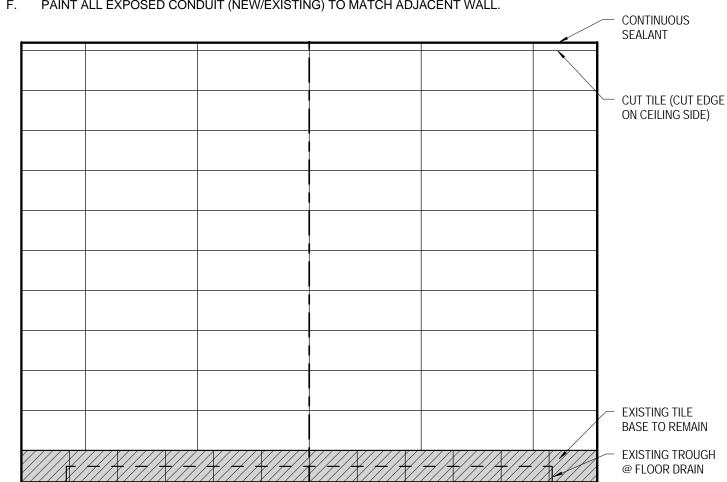

TILE TO BE CENTERED ON EXISTING TILE BASE. REVIEW START PLACE FOR INSTALLATION OF TILE W/ ARCHITECT

WALL TILE LEGEND

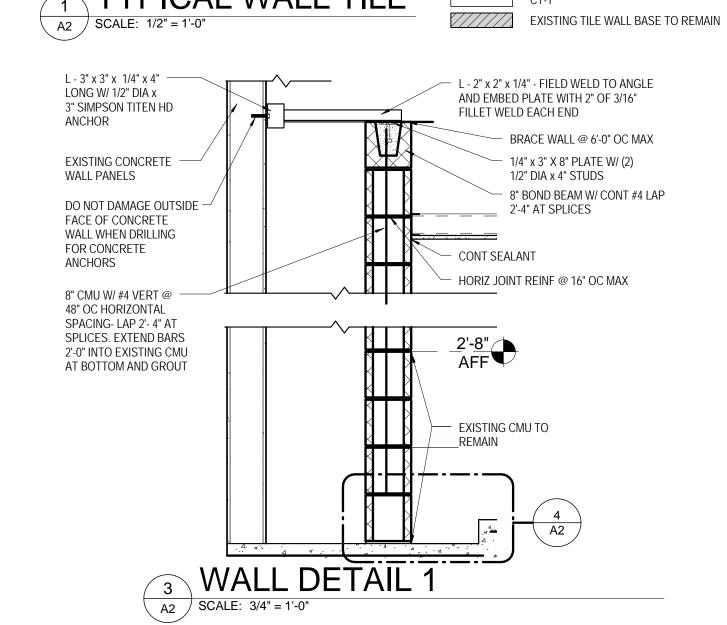

CMU NOTES:


SERIES:

COLOR: SIZE:


A. CONCRETE MASONRY UNITS: ASTM C90, GRADE N, LIGHTWEIGHT.


B. GROUT: 2500 PSI COARSE GROUT IN ACCORDANCE WITH ASTM C476, WITH 8" TO 11" SLUMP. GROUT ALL CELLS WHICH CONTAIN REINFORCEMENT.

C. MORTAR: TYPE S IN ACCORDANCE WITH ASTM C270

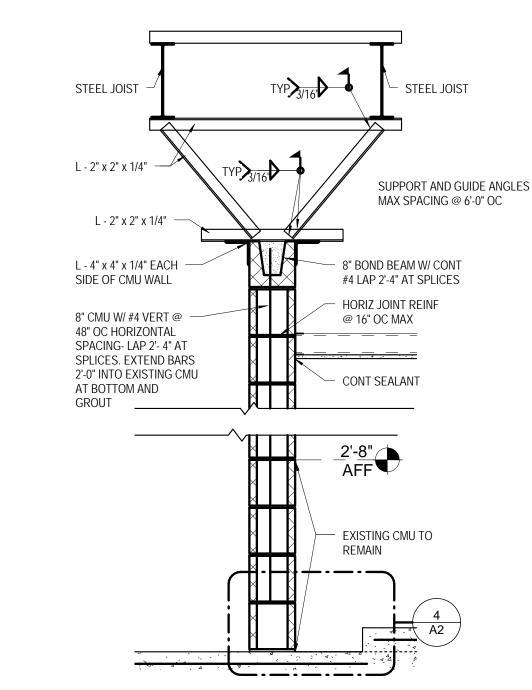


2 WALL DETAIL
A2 SCALE: 3/4" = 1'-0"

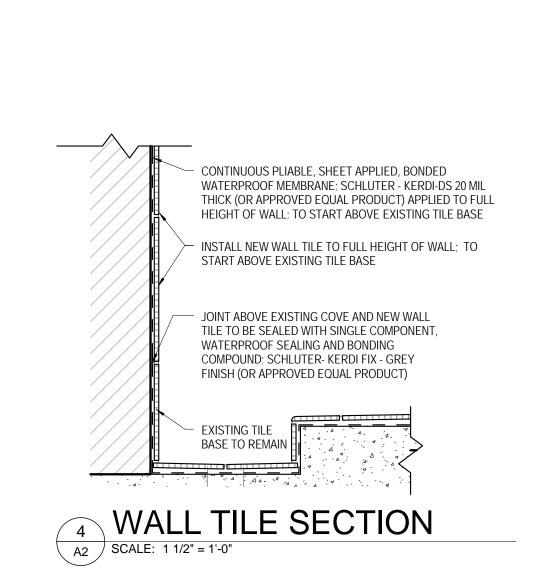

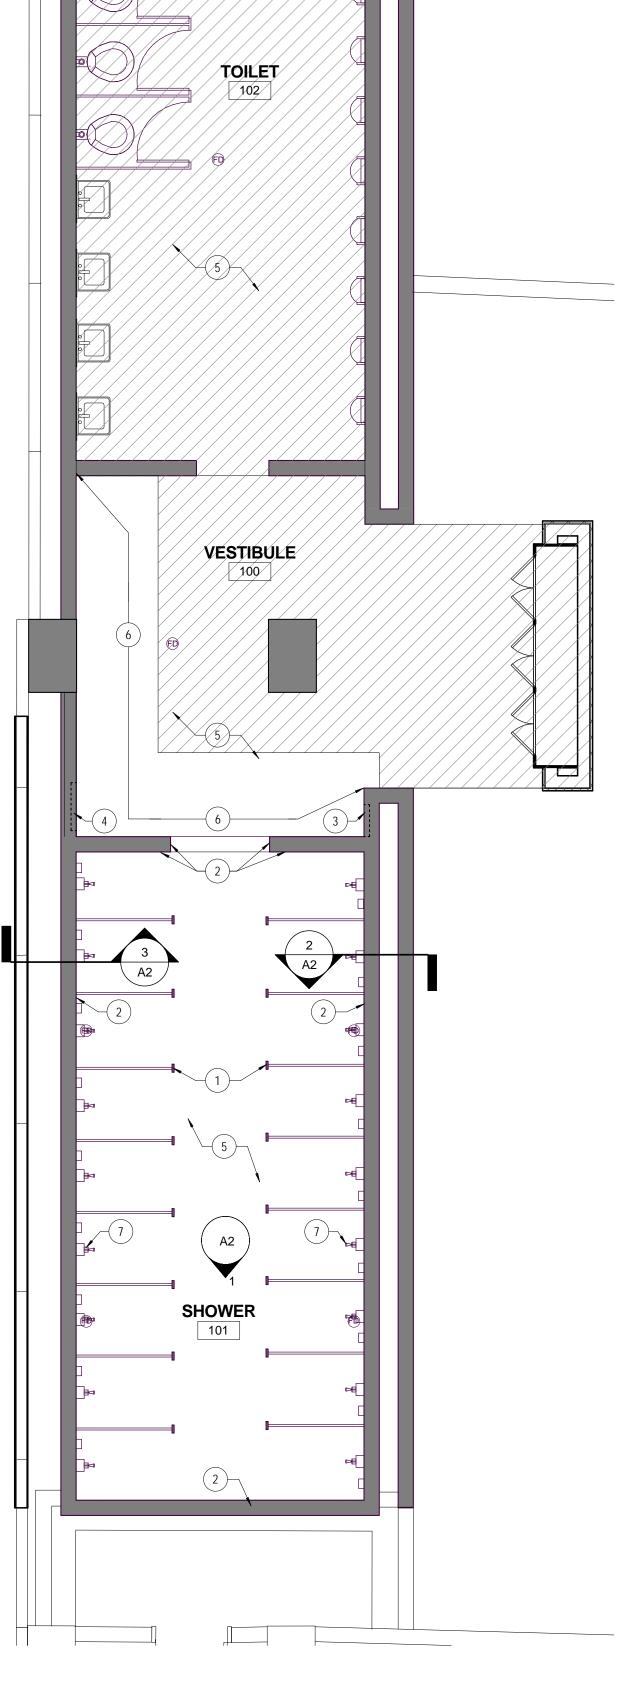



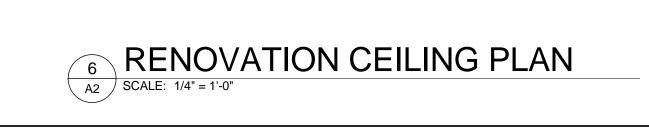

EXISTING LIGHT FIXTURE

FROM DEMOLITION -

-REINSTALL IN SAME

LOCATION; TYP

NEW GRILLE - -

SEE MECHANICAL

EXHAUST FAN (EF-1)

- SEE MECHANICAL

NEW GRILLE -SEE MECHANICAL

RENOVATION

STATE PROJECT NO.

SHEET NO

M1

AIR DISTRIBUTION SCHEDULE MANUFACTURER MODEL FRAME CFM NECK SIZE FACE SIZE MAX NC REMARKS DESCRIPTION AMDE SURFACE 351-500 12"x12" 18"x18" LOUVERED SUPPLY PRICE 25 1,2,3,4 SURFACE 0-500 12"x12" 14"x14" 25 LOUVERED EXHAUST PRICE 97 1,2,4

. PROVIDE WITH STANDARD WHITE FINISH. . PROVIDE ALUMINUM CONSTRUCTION. 3. PROVIDE WITH 4-WAY THROW AND BEVELLED FRAME. 4. PROVIDE WITH OPPOSED BLADE BALANCING DAMPER.

	Ε>	(HAUS	T FAN	SCH	EDULE	-	
TAG	GREENHECK MODEL NO.	TYPE	CFM	ESP	MOTOR H.P./W	SONES (MAX.)	REMARKS
EF-1	SP-A1550	CEILING	1,500	0.25	640 W	10	1,2
_1 _ 1	31 - A1000	CLILING	1,500	0.23	0+0 W	10	1,2

	NOTES TO SHEET	
1) REMOVE EXISTING	GRILLE/DIFFUSER AND INSTALL NEW IN NEW CEILII	NG.

	E>	(HAUS	T FAN	SCH	EDUL	=	
TAG	GREENHECK MODEL NO.	TYPE	CFM	ESP	MOTOR H.P./W	SONES (MAX.)	REMARKS
EF-1	SP-A1550	CEILING	1,500	0.25	640 W	10	1,2

	PROVIDE WITH WHITE ALUMINUM CEILING GRILLE, BACKDRAFT DAMPER, DISCONNECT	
	SWITCH, AND FAN MOUNTED SPEED CONTROL.	
<u>.</u> .	PROVIDE CEILING MOUNTED DEHUMIDISTAT ADJUSTABLE FROM 20% TO 80% RH AND	
	WIRED TO OPERATE FAN.	

	LEGEND					
SYMBO	DL	DESCRIPTION				
<u>(A)</u> 10	0	TYPE "A" DIFFUSER, 100 CFM				
⊝10	0	EXISTING DIFFUSER, 100 CFM				
Θ		RELATIVE HUMIDITY SENSOR				

GENERAL NOTES

VISIT SITE PRIOR TO BIDDING. THIS CONTRACTOR SHALL DETERMINE DIFFICULTY

2. DO NOT SCALE DRAWINGS. THIS CONTRACTOR SHALL VERIFY ALL EXISTING ITEMS

3. ALL DUCTWORK LOCATIONS SHALL BE COORDINATED WITH WORK UNDER OTHER

4. EXISTING PIPE, DUCTWORK, CONDUIT, ETC. THAT INTERFERES WITH THE ROUTING OF NEW SYSTEMS SHALL BE RELOCATED. THIS CONTRACTOR SHALL INCLUDE THE

5. ALL MECHANICAL ITEMS EXTENDING THROUGH WALLS SHALL BE FLASHED AND

6. THIS CONTRACTOR SHALL PROVIDE ALL ITEMS OF MISCELLANEOUS STEEL AS

THIS CONTRACTOR SHALL DO ALL CONTROL WIRING. ELECTRICAL CONTRACTOR WILL DO ALL POWER WIRING. ALL WIRING SHALL BE IN ACCORDANCE WITH NATIONAL ELECTRIC CODE. CONTROL WIRING SHALL BE ROUTED IN EMT CONDUIT

8. ITEMS REMOVED UNDER THIS CONTRACT SHALL BECOME THE PROPERTY OF THE CONTRACTOR AND SHALL BE DISPOSED OF PROPERLY.

OF INSTALLATION AND REFLECT THIS IN HIS BIDDING.

DIVISIONS OF THE SPECIFICATIONS TO AVOID INTERFERENCE.


COST OF SUCH IN HIS BID UNLESS NOTED OTHERWISE.


REQUIRED FOR INSTALLATION OF ALL MECHANICAL ITEMS.

AND CONCEALED WITHIN WALLS AND ABOVE CEILINGS.

AND LOCATIONS IN THE FIELD.

COUNTERFLASHED.

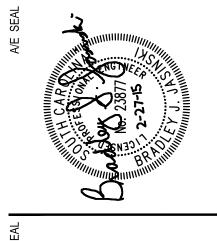

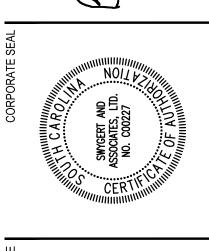

CONSTRUCTION DOCUMENTS

02.27.2015 PROJECT NO. CP00419682 DATE

REVISION

FLOOR PLAN, NOTES, SCHEDULES, AND LEGEND

HOLD DUCT AS HIGH AS POSSIBLE — AND TIGHT TO CONCRETE STRUCTURE

24x24 ALUMINUM EXHAUST LOUVER; — PROVIDE RUSKIN OR APPROVED EQUAL

PROVIDE RUSKIN OR APPROVED EQUAL
MODEL ELF211 WITH BIRDSCREEN,
CONCEALED MOUNTING, AND KYNAR FINISH
OF COLOR TO BE SELECTED BY OWNER;
FIELD COORDINATE EXACT LOCATION OF
LOUVER WITH EXISTING CONDITIONS;
LOUVER OPENING SHALL BE SAW CUT
AND SHALL BE CENTERED HORIZONTALLY
IN CONCRETE PANEL — DO NOT OVERCUT

AT CORNERS; PROVIDE 6" DEEP GALVANIZED METAL PLENUM FULL SIZE OF LOUVER AND PAINT INSIDE SURFACE OF LOUVER FLAT BLACK EXISTING EXHAUST DUCT BACK TO EXISTING HEAT RECOVERY AHU-1

EXISTING SUPPLY DUCT

CEILING MOUNTED ADJUSTABLE DEHUMIDISTAT

REMOVE PORTION OF EXHAUST

DUCT TO ALLOW FOR EF-1 INSTALLATION; CAP EXISTING

TO CONTROL EF-1

DUCT AND SEAL


EXISTING AHU-1:
AT THE EXISTING HEAT RECOVERY AIR HANDLING UNIT (AHU-1) WHICH SERVERS THE FOOTBALL LOCKER ROOM, THE EXHAUST FAN SHALL BE BALANCED TO 3,600 CFM WHICH INCLUDES THE 3,100 CFM SHOWN ON THIS PLAN AND AN ADDITIONAL 500 CFM EXHAUSTED FROM THE ADJACENT MANAGER'S LOCKER ROOM. ADJUST AND/OR REPLACE FAN PULLEY AS REQUIRED. PROVIDE CERTIFIED TEST AND BALANCE REPORT AT PROJECT COMPLETION SHOWING GRILLE AIRFLOWS ADJUSTED TO WITHIN 10% OF DESIGN.

CONSTRUCTION DOCUMENTS STATE PROJECT NO.

GROUND LEVEL FLOOR PLAN - A

Swygert & Associates CONSULTING ENGINEERS DBA Swygert & Assoc., Ltd.
Post Office Box 11686
Columbia, S.C. 29211

Telephone: (803) 791-9300
Facsimile: (803) 791-0830
mail@swygert-associates.com

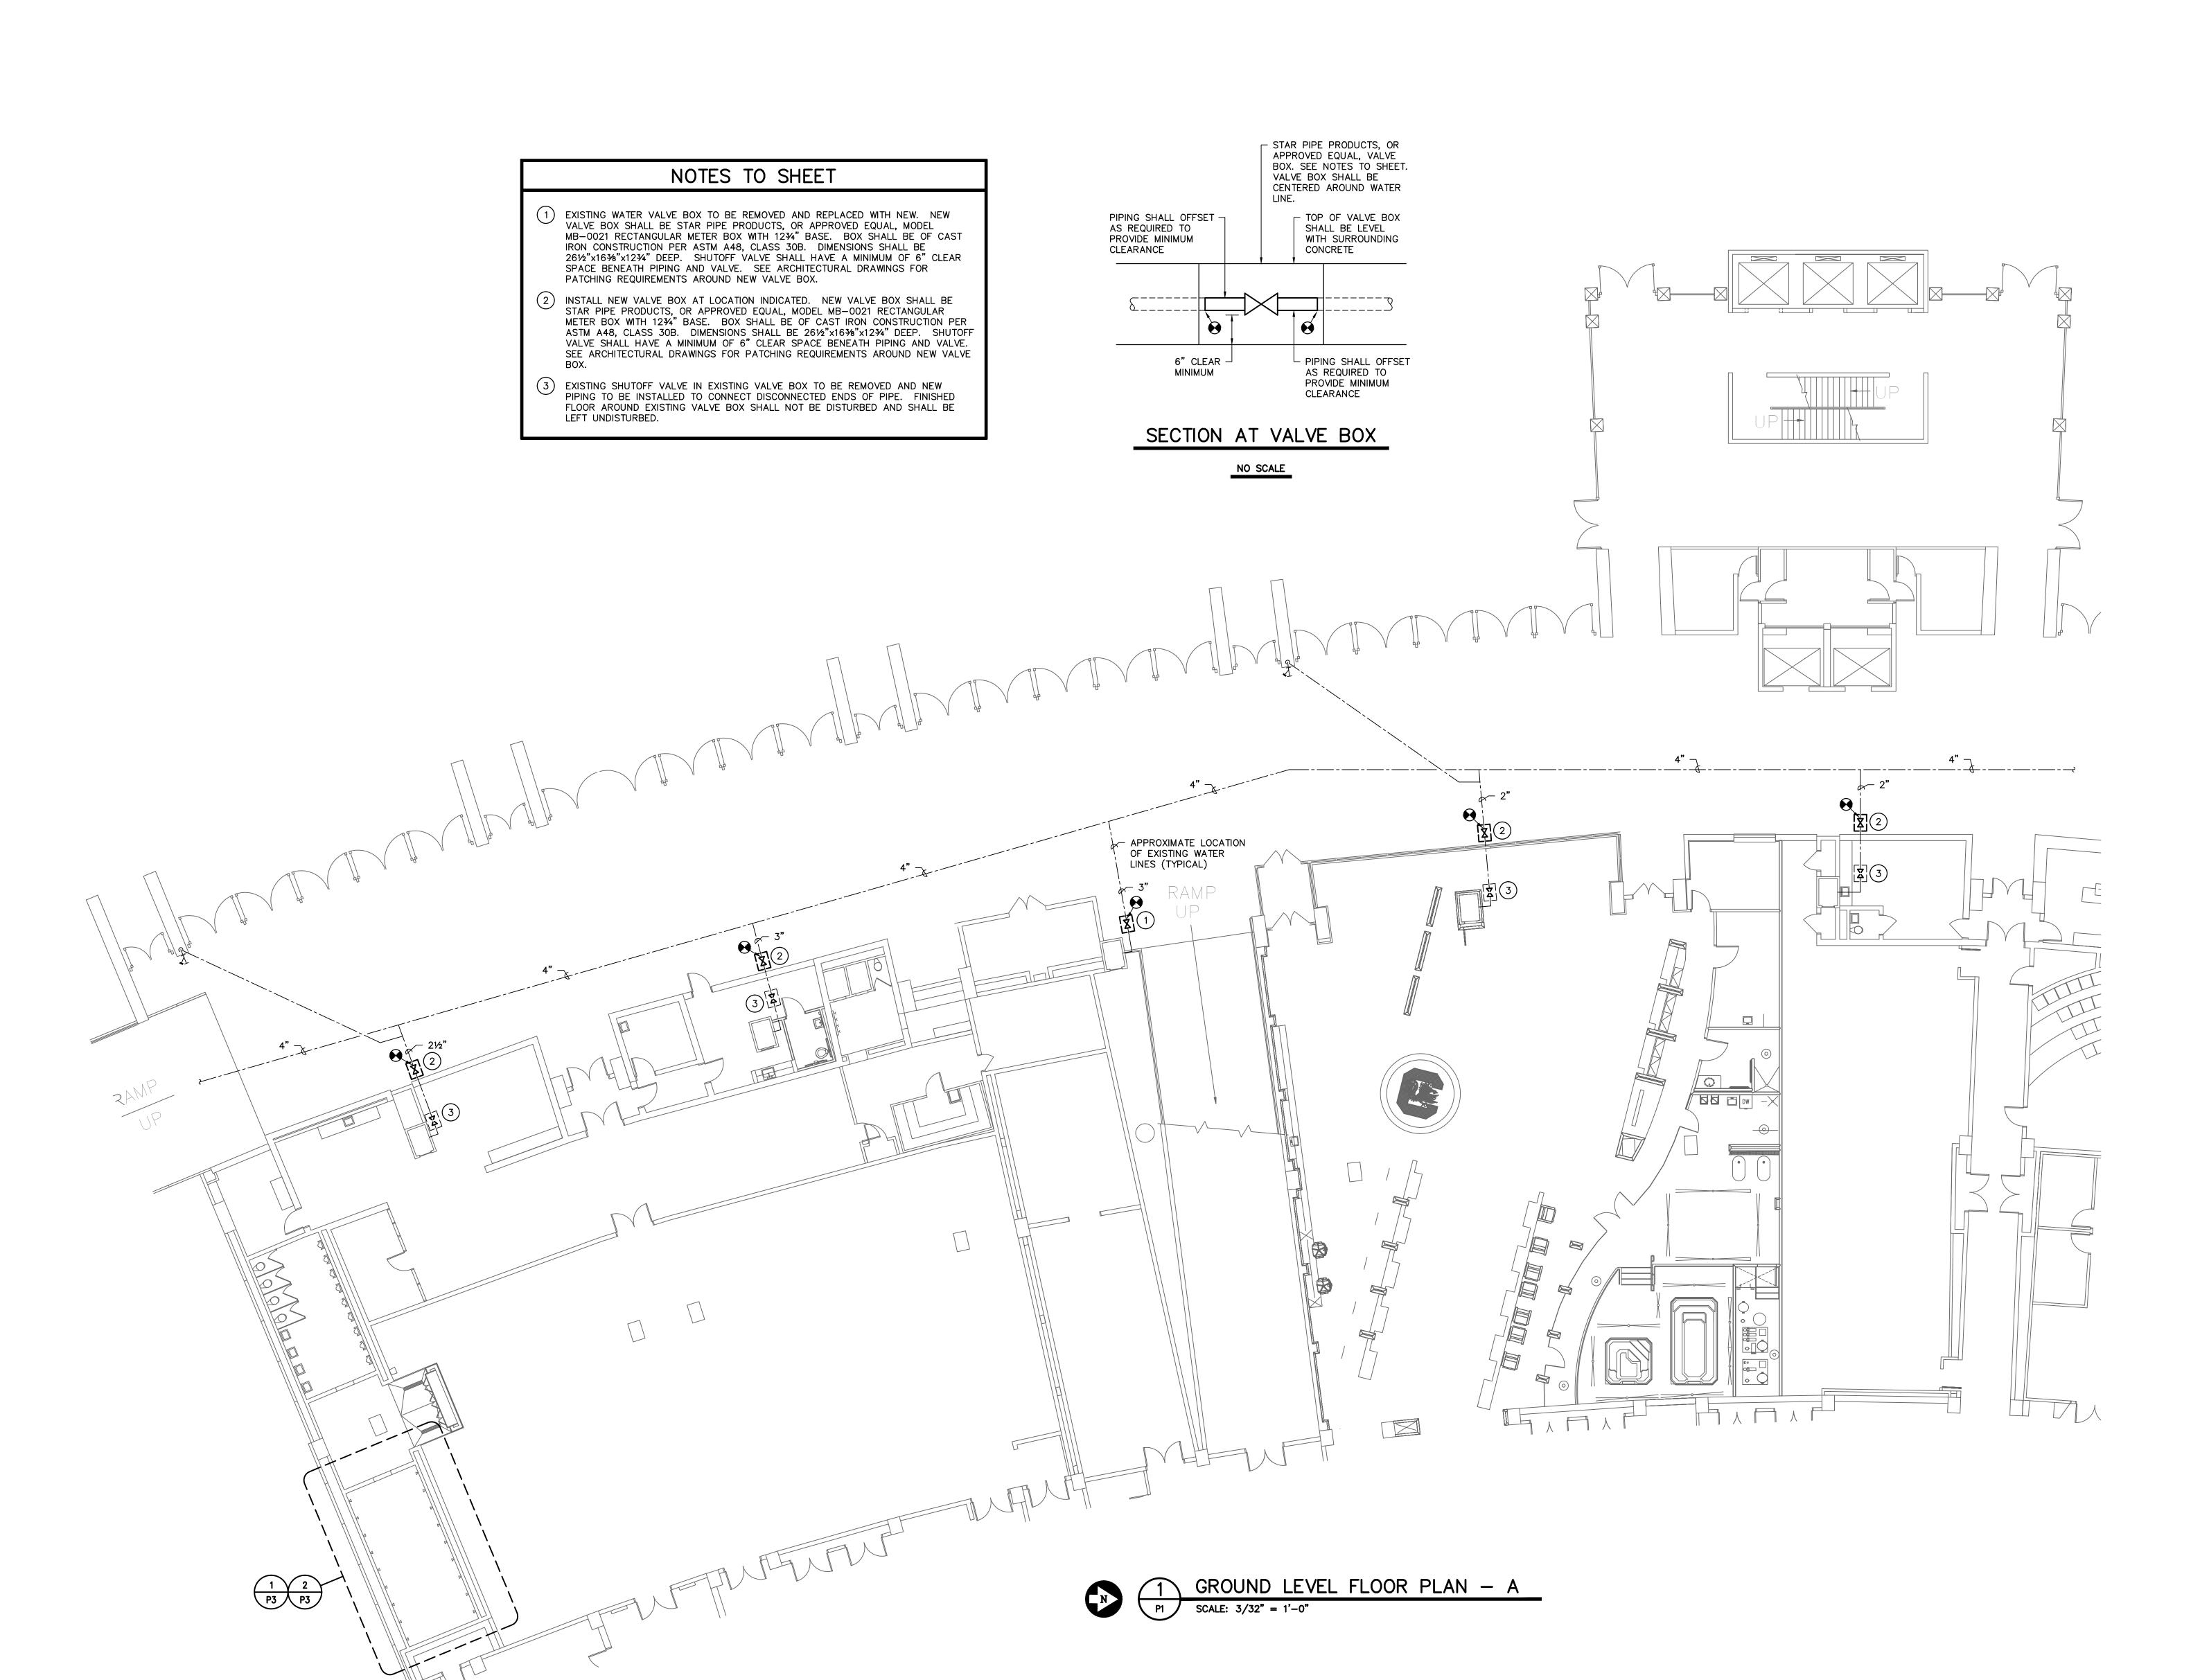

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PHASE

CONSTRUCTION DOCUMENTS

ISSUE DATE 02
PROJECT NO.

STATE PROJECT NO.

REVISION

REVISION

LE

Associates

ENGINEERS

GROUND LEVEL
FLOOR PLAN - B

Swygert & Associates


CONSULTING ENGINEERS

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Facsimile: (803) 791-0830
mail@swygert-associates.com

9300

P2

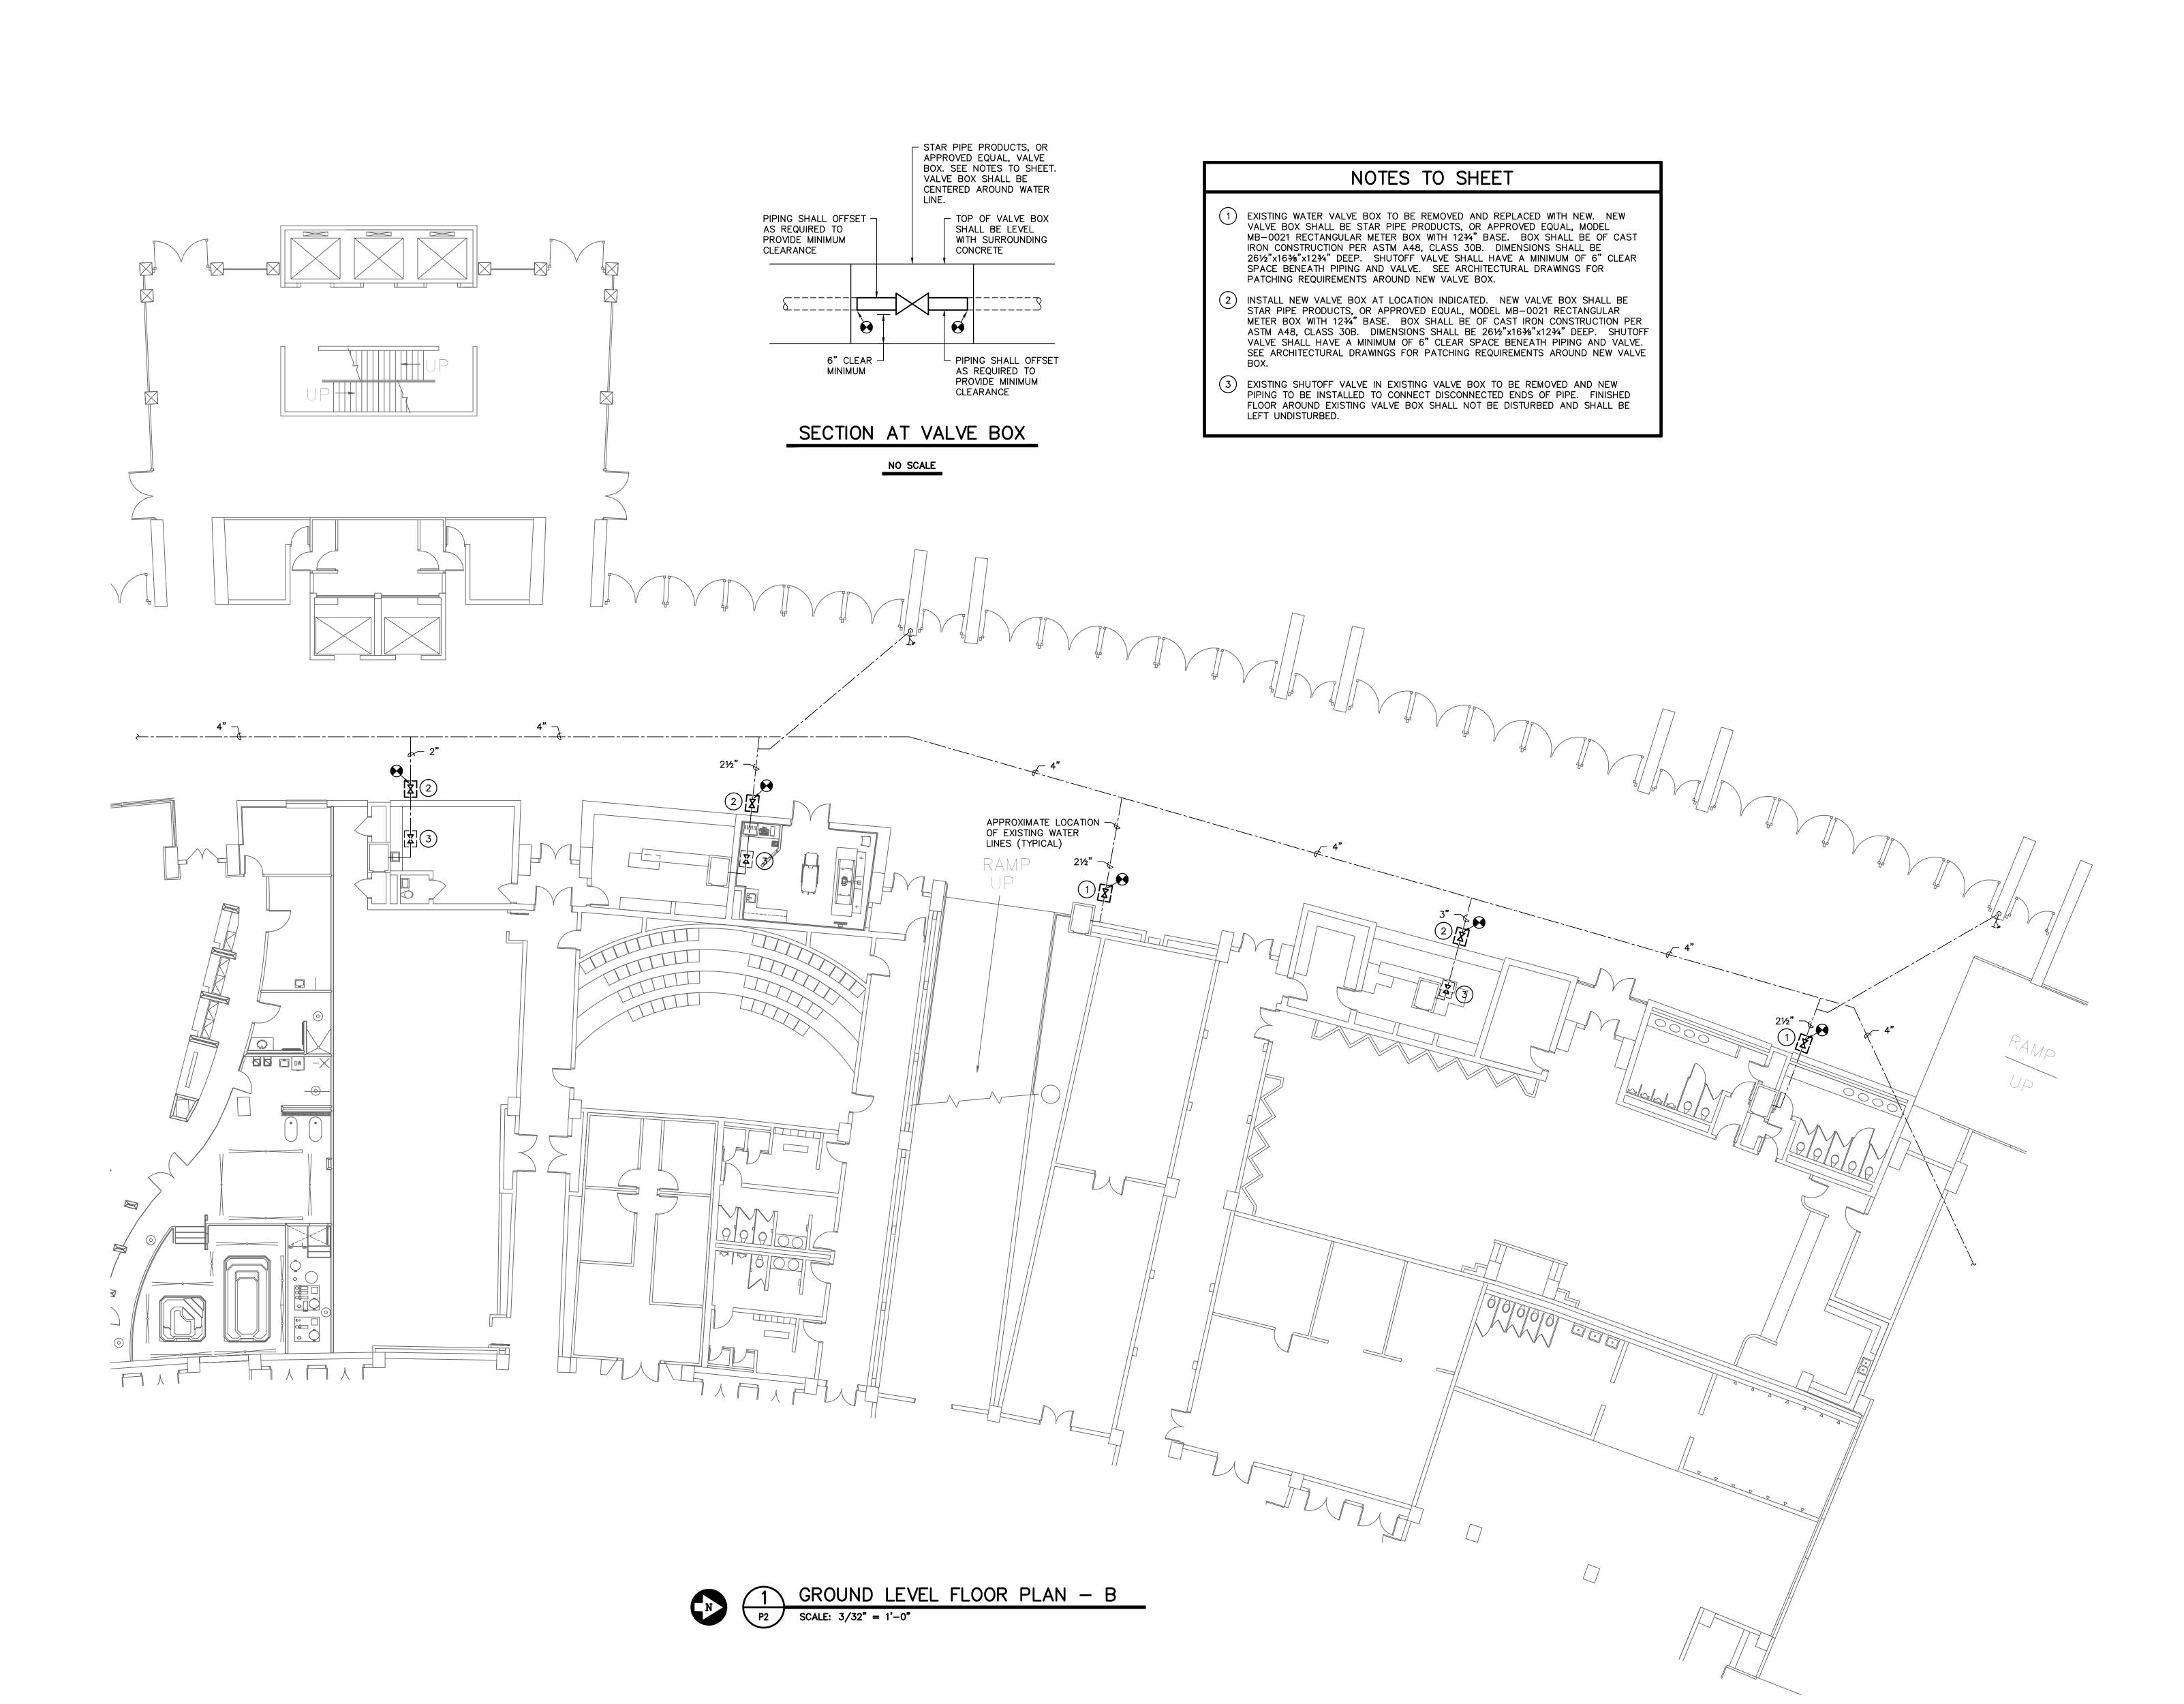

PLUMBING FIXTURE SCHEDULE										
						MIN. S	UPPLY			
0.	FIXTURE	MFGR.	NAME	MFGRS. NO.	SIZE	CW	HW	REMARKS		
	SHOWER	SYMMONS	HYDAPIPE	1-901-22 (MODIFIED)	- 1	1/2"	1/2"	MODIFIED TO HAVE SHOWER HEAD HEIGHT AT 6'-9" AND VALVE BODY AT 4'-0" ABOVE FINISHED FLOOR. STAINLESS STEEL COVERING TO BE ADJUSTED ACCORDINGLY. VALVE SHALL BE COMPLETE WITH LEVER HANDLE AND NO SHOWER HEAD.		

DEMOLITION NOTES

- EXISTING SHOWER VALVE ASSEMBLY AND PIPING TO BE REMOVED COMPLETELY. EXISTING SHOWER HEADS TO BE REMOVED AND REINSTALLED ON NEW SHOWER VALVE ASSEMBLY.
- \bigcirc EXISTING SUPPLY PIPING IN CHASE TO BE REMOVED BACK TO 4" ABOVE FINISHED FLOOR.

GENERAL NOTES

- 1. ALL WORK SHALL BE PERFORMED ACCORDING TO ALL LOCAL, STATE, NATIONAL CODES, AND THE 2012 INTERNATIONAL PLUMBING CODE.
- 2. THIS CONTRACTOR SHALL, PRIOR TO BIDDING, VISIT SITE AND DETERMINE SCOPE OF WORK AND POINTS OF CONNECTION FOR NEW WORK.
- 3. DO NOT SCALE DRAWINGS. SEE ARCHITECTURAL DRAWINGS FOR EXACT

DIMENSIONS, FIXTURE LOCATIONS, ETC.


- 4. COORDINATE CLOSELY WITH ALL WORK DONE UNDER OTHER DIVISIONS OF THE SPECIFICATIONS TO AVOID INTERFERENCE AND CONFLICT.
- 5. ALL HEIGHTS LISTED SHALL BE RELATIVE TO THE FINISHED FLOOR WHERE THE

USER WILL STAND, NOT THE DRAINAGE TRENCH ADJACENT TO THE WALL.


6. EXISTING INFORMATION TAKEN FROM OWNERS RECORD SET OF DRAWINGS DATED OCTOBER 1970 AND OCTOBER 1971.

NOTES TO SHEET

- CONNECT TO EXISTING SUPPLY LINES AT 4" ABOVE FINISHED FLOOR SLAB
 (MAXIMUM) OFFSET AS REQUIRED SO THAT NEW SHITTOFF VALVES ARE (MAXIMUM). OFFSET AS REQUIRED SO THAT NEW SHUTOFF VALVES ARE LOCATED BEHIND NEW ACCESS PANELS. SEE ARCHITECTURAL.
- 2 PIPING TO ROUTED HORIZONTALLY IN CHASE AT APPROXIMATELY 3'-6" ABOVE FINISHED FLOOR.
- 3) EXTEND SHOCK ABSORBER TO ABOVE CMU WALL.
- 4 ACCESS PANEL (BY OTHERS). LOCATE SHUTOFF VALVES AT APPROXIMATELY 3'-0" ABOVE FINISHED FLOÓR. ACCESS PANEL SHALL BE CENTERED ON VALVE LOCATION.

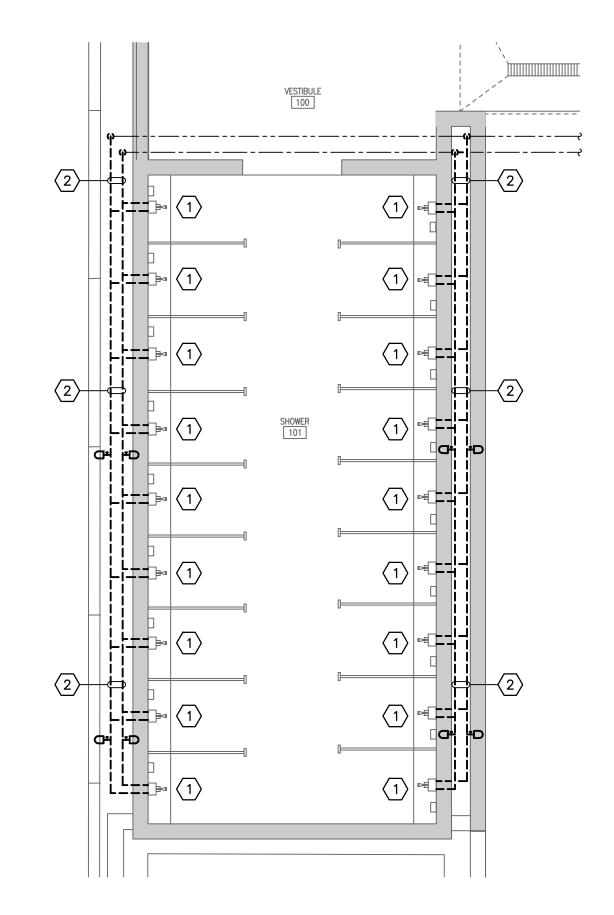



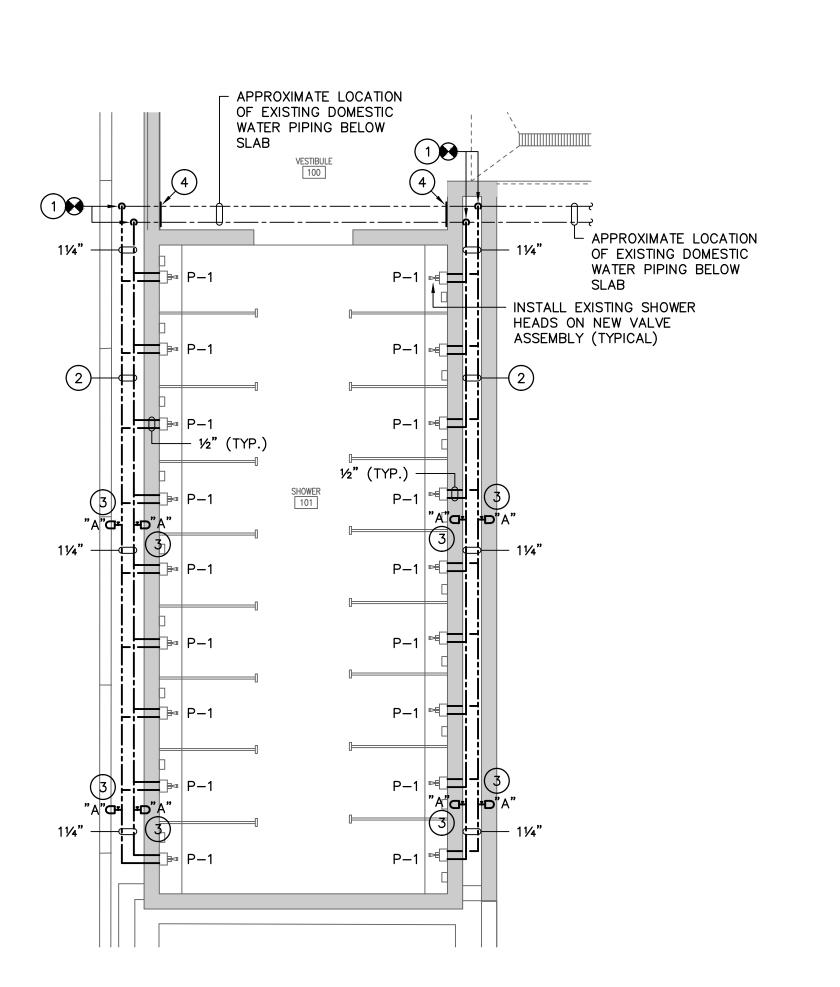





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STATE PROJECT NO.

REVISION

FLOOR PLANS, NOTES, SCHEDULE, AND LEGEND

Swygert & Associates CONSULTING ENGINEERS DBA Swygert & Assoc., Ltd. Telephone: (803) 791-9300 Facsimile: (803) 791-0830 mail@swygert-associates.com DATE

LOCATE EXISTING CONDUIT RACEWAY (AT APPROXIMATELY THIS LOCATION) ABOVE ACOUSTIC CEILING & ROUTE BRANCH CIRCUIT ADJACENT TO EXISTING RACEWAYS FOR AN UN-INTERUPTED PATH TO SHOWER AREA. MOUNT CONDUIT TIGHT TO STRUCTURE WHERE POSSIBLE & AVOID CONFLICT WITH EXISTING CONDITIONS.

RELOCATE TYPE "BE" EMERGENCY LIGHT FIXTURE IN SHOWER 101 (CEILING). REUSE AND EXTEND EXISTING GENERATOR—BACKED CIRCUIT AS REQUIRED. RE—USE EXISTING RELAY SO THAT THESE FIXTURES ARE

_ 120V CKT. & CONDUIT

SCALE: NONE

REFER TO ELECTRIC RISER -DIAGRAM THIS DETAIL #3, THIS SHEET

ELECTRICAL SYMBOL LEGEND EXISTING LIGHT FIXTURES. FIXTURES LABELED "R" SHALL BE DISCONNECTED, REMOVED & STORED. FIXTURES CONSTRUCTION.

LABELED "RE" ARE RELOCATED FIXTURE LOCATIONS POST EXISTING SINGLE POLE SWITCH TO BE REMOVED BY THIS CONTRACTOR. REUSE EXISTING BOX AND CONDUCTORS. EXISTING RECEPTACLE (SHOWN FOR REFERENCE ONLY)

EXISTING CEILING MOUNTED FIRE ALARM VISUAL DEVICE FOR RELOCATION AFTER NEW CEILING IS INSTALLED.

EXHAUST FAN "EF-1". REFER TO MECHANICAL DRAWINGS FOR ADDITIONAL INFORMATION.

EXHAUST FAN "EF-1". REFER TO MECHANICAL DRAWINGS FOR ADDITIONAL INFORMATION.

RENOVATION KEY NOTE CALLOUT (REFER TO NOTES)

DEMOLITION KEY NOTE CALLOUT (REFER TO NOTES)

	ABBREVIATIONS
ABR	DESCRIPTION
ETR	EXISTING
EF	EXHAUST FAN
CLG	CEILING
FACP	FIRE ALARM CONTROL PANE
J-BOX	JUNCTION BOX
NEC	NATIONAL ELECTRIC CODE
SD	SMOKE DETECTOR

FOR ROUTING OF DUCTS. PIPES AND OTHER COMPONENTS WITH EXISTING CONDITIONS. CONTRACTOR SHALL BE RESPONSIBLE FOR FIELD VERIFYING SOURCE OF RACEWAYS AND CABLING THAT ARE IN CONFLICT REGARDLESS OF WHETHER THEY SERVE DEVICES IN THE AREA OF WORK OR NOT. THE RELOCATION OF THESE RACEWAYS TO ASSIST IN AVOIDING THESE CONFLICTS SHALL ALSO BE INCLUDED AT NO ADDITIONAL COST TO OWNER. WHEREVER ON THE ELECTRICAL DRAWINGS THE WORD "PROVIDE" IS USED, IT SHALL BE INFERRED TO MEAN "FURNISH AND INSTALL",

SMOKE DETECTOR UNO UNLESS OTHERWISE NOTED WITH

WEATHERPROOF

| ELECTRICAL DEMOLITION KEY NOTES |

EXISTING ELECTRICAL DEVICES ON FEATURE WALL SHALL REMAIN CONNECTED IN CURRENT LOCATION. REMOVE & STORE FIRE ALARM DEVICES. INSPECT & ADVISE OWNER IF REPLACEMENT IS NECESSARY TO

11 THE ARRANGEMENT, GROUPING, AND ROUTING OF BRANCH CIRCUITS SHALL BE PROVIDED AT THE

THE NATIONAL ELECTRICAL CODE REQUIREMENTS, LOCAL ORDINANCES, AND THE FOLLOWING:

ENSURE PROPER FUNTIONALITY. NO ELECTRICAL WORK IN SCOPE. ALL FIXTURES & DEVICES SHALL REMAIN CONNECTED IN CURRENT LOCATION. INSPECT ALL FIXTURES & DEVICES TO ENSURE PROPER FUNCTIONALITY & ADVISE OWNER OF ANY DEFICIENCIES. RELAMP, REPAIR OR REPLACE ONLY WITH EXPRESS WRITTEN CONSENT OF OWNER OR OWNERS REPRESENTATIVE. UNLESS NOTED OTHERWISE IN PLAN.

GENERAL NOTES

SHALL BE NOTIFIED AS SOON AS POSSIBLE. NO ADDITIONAL ELECTRICAL REWORK SHALL COMMENCE

IN AREAS WHERE THE EXISTING CEILINGS ARE NOT SLATED TO BE REMOVED, THE CONTRACTOR SHALL WORK THRU THE EXISTING CEILINGS (SEE ARCHITECTURAL REFLECTED CEILING PLAN FOR AREA OF WORK).

WITHOUT COORDINATION OF BOTH ARCHITECT AND ENGINEER.

REQUEST. SEE ARCHITECTURAL DRAWINGS FOR LOCATIONS OF FIREWALLS.

DAMAGED DURING CONSTRUCTION SHALL BE REPLACED BY THE CONTRACTOR.

OF THEIR WORK.

CONSTRUCTION AREA.

CONSTRUCTION AREA.

AREAS OF WORK EXIST FOR THIS PROJECT WHICH ARE NOT ACCESSIBLE OR HAVE LIMITED ACCESS DURING

DESIGN. AS SUCH CONTRACTOR SHALL VERIFY ALL CONDITIONS IN AREA OF WORK BEFORE ANY DEMOLITION

THE CONTRACTOR SHALL BE RESPONSIBLE FOR REPLACING ANY DAMAGED TILE OR GRID THAT IS A RESULT

SEAL ALL EXISTING AND NEW FIRE RATED WALL PENETRATIONS IN THE CONSTRUCTION AREA CREATED BY

CONTRACTOR SHALL PROTECT ALL EXISTING LOW-VOLTAGE CABLING FROM DAMAGE. IF CONFLICTS ARISE,

PROVIDE JUNCTION BOX COVER PLATES ON ALL EXISTING JUNCTION BOXES ABOVE THE CEILING IN THE

CONTRACTOR SHALL BE RESPONSIBLE FOR COORDINATING WITH CONTRACT DOCUMENTS AND OTHER TRADES

20A/120V BRANCH CIRCUITS EXCEEDING 100' IN LENGTH FROM PANEL TO FARTHEST DEVICE OR FIXTURE

10 RACEWAYS SHALL BE INSTALLED CONCEALED IN NEW WALL CONSTRUCTION ABOVE CEILINGS, BELOW FLOOR,

CONTRACTOR'S DISCRETION IN ACCORDANCE WITH GENERALLY ACCEPTED PRACTICE FOR ELECTRICAL WORK,

THE REMOVAL OF EXISTING ELECTRICAL CONDUIT, AS WELL AS THOSE CREATED BY NEWLY INSTALLED CONDUITS AND SLEEVES. CONTRACTOR SHALL ALSO PROVIDE DETAILS OF FIRESTOP SYSTEM UPON

REMOVE ALL ABANDONED CONDUIT, WIRE, AND COMMUNICATION CABLES ABOVE THE CEILING IN THE

CONTACT ARCHITECT IMMEDIATELY TO DETERMINE STATUS OF CABLING. EXISTING CABLING THAT IS

BEGINS. ANY ELECTRICAL DEVICES NOT SHOWN SHALL BE IDENTIFIED AND THE ARCHITECT AND ENGINEER

THE ELECTRICAL CONTRACTOR SHALL BE RESPONSIBLE FOR DISCONNECTING & STORAGE OF, ALL LIGHT FIXTURES, FIRE ALARM DEVICES & EQUIPMENT DURING RENOVATION WHETHER SHOWN ON THE DRAWINGS

) ELECTRICAL RENOVATION KEY NOTES (#)

CONNECT RELOCATED FIXTURES TO EXISTING LIGHTING CIRCUITS. (CIRCUIT SHOWN IN PLAN FOR REFERENCE ONLY). REUSE EXISTING BREAKERS. PROVIDE #12 SOLID COPPER INSULATED CONDUCTORS IN EMT FOR CONDUIT WITH EACH BRANCH CIRCUIT.

EXISTING CIRCUIT PER AS—BUILT DRAWING. (TYPICAL)

SHALL USE NO. 10 CONDUCTORS AND 3/4"C.

AND IN OTHER CAVITIES TO THE GREATEST EXTENT POSSIBLE.

CEILING MOUNT RELOCATED TYPE "RE" FIXTURES SECURELY TO SURFACE SO THERE ARE NO GAPS BETWEEN FIXTURE AND CEILING. ALL MOUNTING HARDWARE SHALL BE STAINLESS STEEL.

NORMALLY OFF AND TURN ON WHEN NORMAL POWER FAILS.

² ELECTRICAL RENOVATION CEILING PLAN

L5-42b

L5-42b

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ALARM.

FIRE ALARM A/V SHOWN RELOCATED TO NEW CEILING. CONTRACTOR TO COORDINATE

RECONNECTION TO EXISTING FIRE

CONTRACTOR TO PROVIDE BREAKER, CONDUIT

& CONDUCTORS FROM NEXT AVAILABLE 120V BREAKER SPACE IN PANEL "LSB" OR "LSC" (AS AVAILABLE), REFER TO KEY PLAN FOR

ROUTING & EXISTING ELECTRICAL RISER FOR

ADDITIONAL INFORMATION.

	LIGHTING FIXTURE SCHEDULE									
SYMBOL	TYPE	DESCRIPTION	MANUFACTURER	MODEL NUMBER	OPTICAL ELEMENT	MOUNTING	VOLTS	LAMPS		
•	R & RE	4' FLUORESCENT FIXTURE, WET LOCATION	EXISTING SHOWN RELOCATED	N/A	POLYCARBONATE LENS	CEILING	120	2 - F32T8/TL741/ALTO		
H	B & BE	12" SQUARE FLUORESCENT FIXTURE	EXISTING SHOWN RELOCATED	N/A	POLYCARBONATE LENS	WALL OR CEILING	120	1 - PL-C 26W/41/ALTO		

* LAMP DESCRIPTIONS ARE PHILIPS CATALOG NUMBERS (UNLESS NOTED OTHERWISE) OR APPROVED EQUAL. * FIXTURE MANUFACTURER & CATALOG NUMBERS ARE SHOWN FOR REFERENCE ONLY AND BASED UPON ASBUILT RECORDS.

TYPICAL FOR

TOILET #102

_ EXISTING WATER


FOUNTAIN

0

TYPICAL FOR

VESTIBULE #100 \

1 ELECTRICAL DEMOLITION PLAN
SCALE: 1/4" = 1'-0"

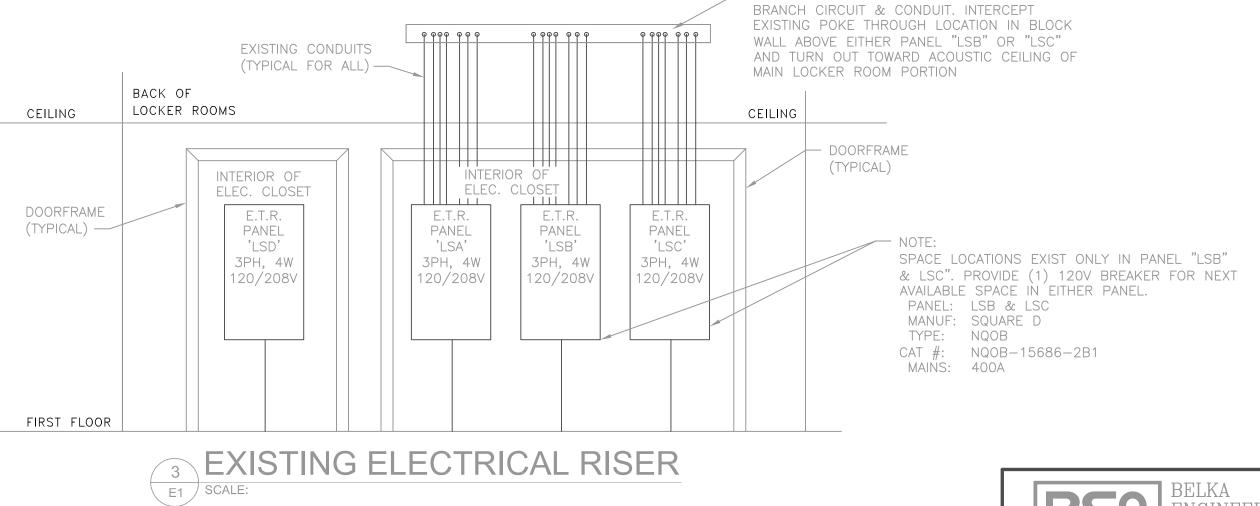

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ELECTRICAL **DEMOLITION &** RENOVATION **PLANS**

SHEET NO

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SUBJECT TO LEGAL ACTION.

ISSUE DATE

PROJECT NO.

REVISION

STATE PROJECT NO.

PHASE

02.27.2015

15.162.00

DATE

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